

### Site & Compliance Information

LGA: Canterbury-Bankstown Council Zoning: R2 Low Density Residential MAXIMUM FSR: 0.55:1 ('Semi-detached house in Clause 2 area on the clause application map') or 183.76m<sup>2</sup>

**PROPOSED FSR:** 0.46:1 or 156.49m<sup>2</sup> Maximum Height Of Building: 'l' 8.5m

Lot Size Map: 'G' 460sqm Maximum Site coverage: 60% Proposed: 178.12m2 or 53.31%

Maximum Building Footprint: 300m2 Proposed Building Footprint: 178.12m2 Minimum Deep Soil Area: 15%

**Proposed:** 59.47m2 or 17.8% (minimum

2.5m calculation area)

Minimum Front Setback: 5.5m Minimum Side Setbacks: 0.9m Minimum Rear Setback: 6m


Impervious Surface Area: 253.04m2 or 75%

#### **Proposed Gross Floor Area**

Existing Ground Floor Area	72.91 m <sup>2</sup>
New Ground Floor Rear Extension	55.05 m <sup>2</sup>
New Lower Ground Floor Stairwell	5.25 m <sup>2</sup>
Existing Lower Ground Floor Laundry	10.47 m <sup>2</sup>
New Ground Floor Side Extension	12.80 m <sup>2</sup>
Grand total	156.49 m <sup>2</sup>

Gross Building Are	ea
New Lower Ground Floor Stairwell	8.00 m <sup>2</sup>
Existing Ground Floor Area	79.57 m <sup>2</sup>
New Ground Floor Rear Extension	60.24 m <sup>2</sup>
New Ground Floor Side Extension	14.61 m <sup>2</sup>
New Ground Floor Stair Void	3.80 m <sup>2</sup>
Existing Lower Ground Floor Laundry	13.32 m <sup>2</sup>
New Balcony	18.27 m <sup>2</sup>
Existing Porch	1.63 m <sup>2</sup>
New Carport	20.80 m <sup>2</sup>
Grand total	220.25 m <sup>2</sup>



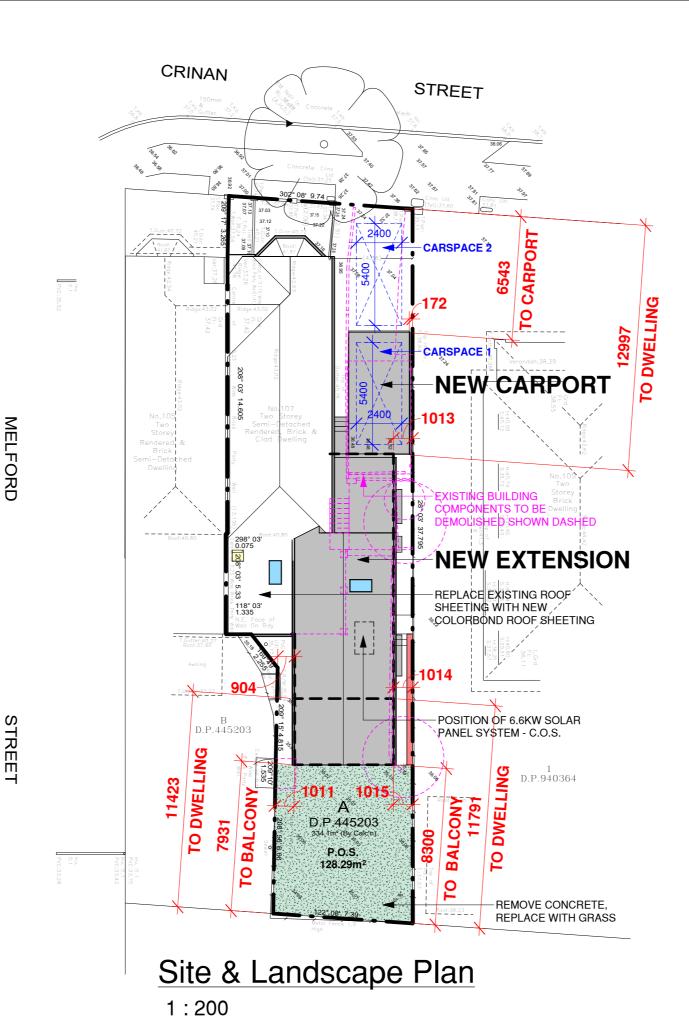

### Site Legend

= GROUND FLOOR OUTLINE



= DEEP SOIL CALCULATION AREA (MINIMUM 2.5M DIMENSION)

Alterations & Additions

At: 107 Crinan Street, Hurlstone Park

For: Donna & George Georgiou

**Development Application & Construction** Certificate



#### True North Design & Drafting Pty Ltd design@truenorthdd.com.au www.truenorthdd.com.au


Issue:	Description:	By:	Date:
Α	Design Review	D.K.	20/04/2024
В	Variations	D.K.	29/05/2024
С	Variations	D.K.	08/06/2024
D	Variations	D.K.	19/06/2024
Е	Variations	D.K.	04/09/2024
F	Variations	D.K.	22/10/2024
1	Issued for DA Submission	D.K.	19/11/2024

- LEVELS SHOWN ARE APPROX.ONLY AND SHOULD BE VERIFIED ON SITE
- DO NOT SCALE USE DIMENSIONS WHERE AVAILABLE.
- WINDOW SIZES ARE INDICATIVE ONLY FINAL SIZES PROVIDED BY
BUILDER AND CONFIRMED ON SITE.
- THE DESIGNER MUST BE NOTIFED OF ANY DISCREPANCIES ON THE
DRAWINGS PRIOR TO ANY CONSTRUCTION WORKS.
- COPYRIGHT OF THIS DRAWING AND/OR DESIGN IS THE PROPERTY OF
TRUE NORTH DESIGN A DRAFTING PTY LTD AND SHOULD NOT BE
REPRODUCED IN PART OR WHOLE WITHOUT THE WRITTEN PERMISSION
OF THE COMPANY

OF THE COMPANY.
- DIAL 1100 BEFORE YOU DIG PRIOR TO ANY EARTH EXCAVATION.

COPYRIGHT ©2023 BY TRUE NORTH DESIGN & DRAFTING PTY LTD. ALL RIGHTS RESERVED.

Scale:	As indicated	43	Issue:
Page:	2 of 18		
Date:	19/11/2024		- 1
Drawing	j No:		

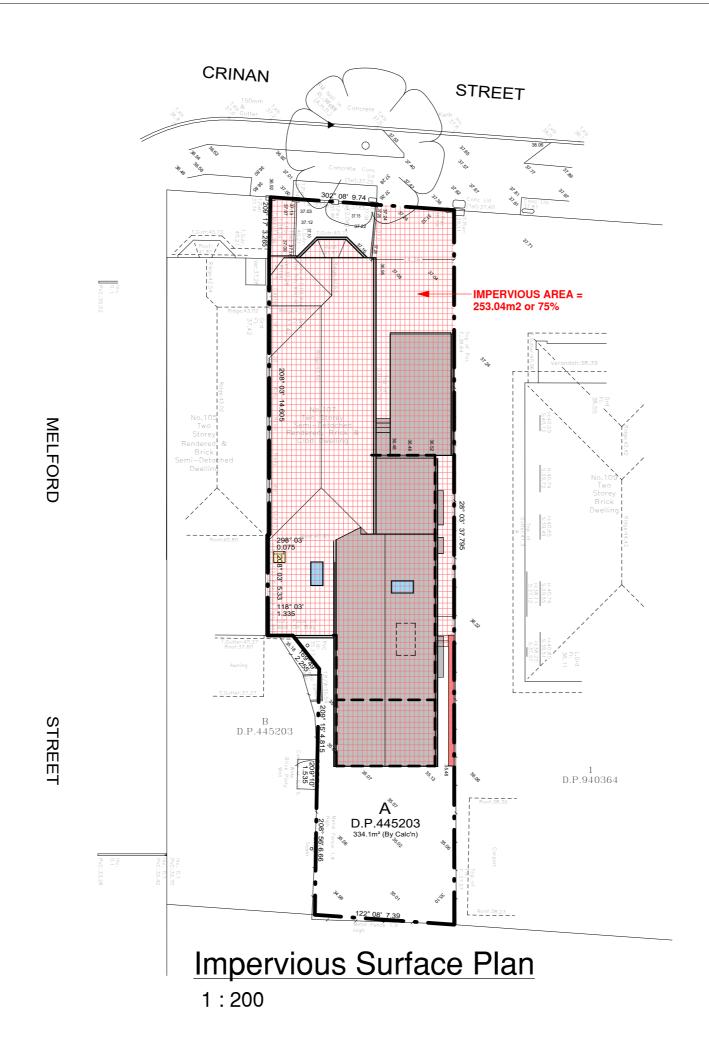



## Site Legend

= GROUND FLOOR OUTLINE



= DEEP SOIL CALCULATION AREA (MINIMUM 2.5M DIMENSION)

Alterations & Additions

At: 107 Crinan Street, Hurlstone Park

For: Donna & George Georgiou

Development Application & Construction Certificate



True North Design & Drafting Pty Ltd design@truenorthdd.com.au www.truenorthdd.com.au

Issue:	Description:	By:	Date:
Α	Design Review	D.K.	20/04/2024
В	Variations	D.K.	29/05/2024
С	Variations	D.K.	08/06/2024
D	Variations	D.K.	19/06/2024
E	Variations	D.K.	04/09/2024
F	Variations	D.K.	22/10/2024
1	Issued for DA Submission	D.K.	19/11/2024


- LEVELS SHOWN ARE APPROX.ONLY AND SHOULD BE VERIFIED ON SITE
- DO NOT SCALE USE DIMENSIONS WHERE AVAILABLE.
- WINDOW SIZES ARE INDICATIVE ONLY FINAL SIZES PROVIDED BY
BUILDER AND CONFIRMED ON SITE.
- THE DESIGNER MUST BE NOTIFED OF ANY DISCREPANCIES ON THE
DRAWINGS PRIOR TO ANY CONSTRUCTION WORKS.
- COPYRIGHT OF THIS DRAWING AND/OR DESIGN IS THE PROPERTY OF
TRUE NORTH DESIGN & DRAFTING PTY LTD AND SHOULD NOT BE
REPRODUCED IN PART OR WHOLE WITHOUT THE WRITTEN PERMISSION
OF THE COMPANY.
- DIAL 1100 BEFORE YOU DIG PRIOR TO ANY EARTH EXCAVATION.

COPYRIGHT ©2023 BY TRUE NORTH DESIGN & DRAFTING PTY LTD. ALL RIGHTS RESERVED.

Scale: As indicated Issue: Page: 3 of 18 Date: 19/11/2024

2409

Drawing No:

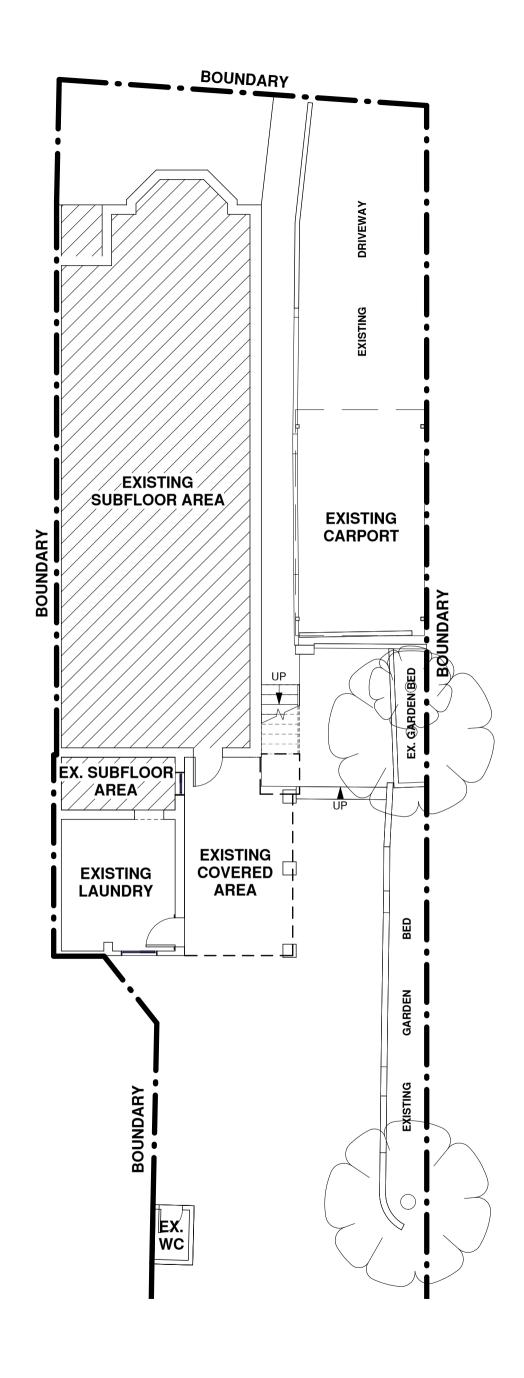



**Existing Lower Ground Floor Plan** 

1:100

Alterations & Additions

107 Crinan Street, **Hurlstone Park** 

For: Donna & George Georgiou

Development Application & Construction Certificate




True North Design & Drafting Pty Ltd design@truenorthdd.com.au www.truenorthdd.com.au


Issue:	Description:	By:	Date:
Α	Design Review	D.K.	20/04/2024
В	Variations	D.K.	29/05/2024
С	Variations	D.K.	08/06/2024
D	Variations	D.K.	19/06/2024
Е	Variations	D.K.	04/09/2024
F	Variations	D.K.	22/10/2024
1	Issued for DA Submission	D.K.	19/11/2024

- LEVELS SHOWN ARE APPROX.ONLY AND SHOULD BE VERIFIED ON SITE
- DO NOT SCALE USE DIMENSIONS WHERE AVAILABLE.
- WINDOW SIZES ARE INDICATIVE ONLY FINAL SIZES PROVIDED BY
BUILDER AND CONFIRMED ON SITE.
- THE DESIGNER MUST BE NOTIFED OF ANY DISCREPANCIES ON THE
DRAWINGS PRIOR TO ANY CONSTRUCTION WORKS.
- COPYRIGHT OF THIS DRAWING AND/OR DESIGN IS THE PROPERTY OF
TRUE NORTH DESIGN & DRAFTING PTY LTD AND SHOULD NOT BE
REPRODUCED IN PART OR WHOLE WITHOUT THE WRITTEN PERMISSION
OF THE COMPANY OF THE COMPANY.
- DIAL 1100 BEFORE YOU DIG PRIOR TO ANY EARTH EXCAVATION.

COPYRIGHT ©2023 BY TRUE NORTH DESIGN & DRAFTING PTY LTD. ALL RIGHTS RESERVED.

1:100 Scale: Issue: Page: 4 of 18 Date: 19/11/2024 Drawing No: 2409

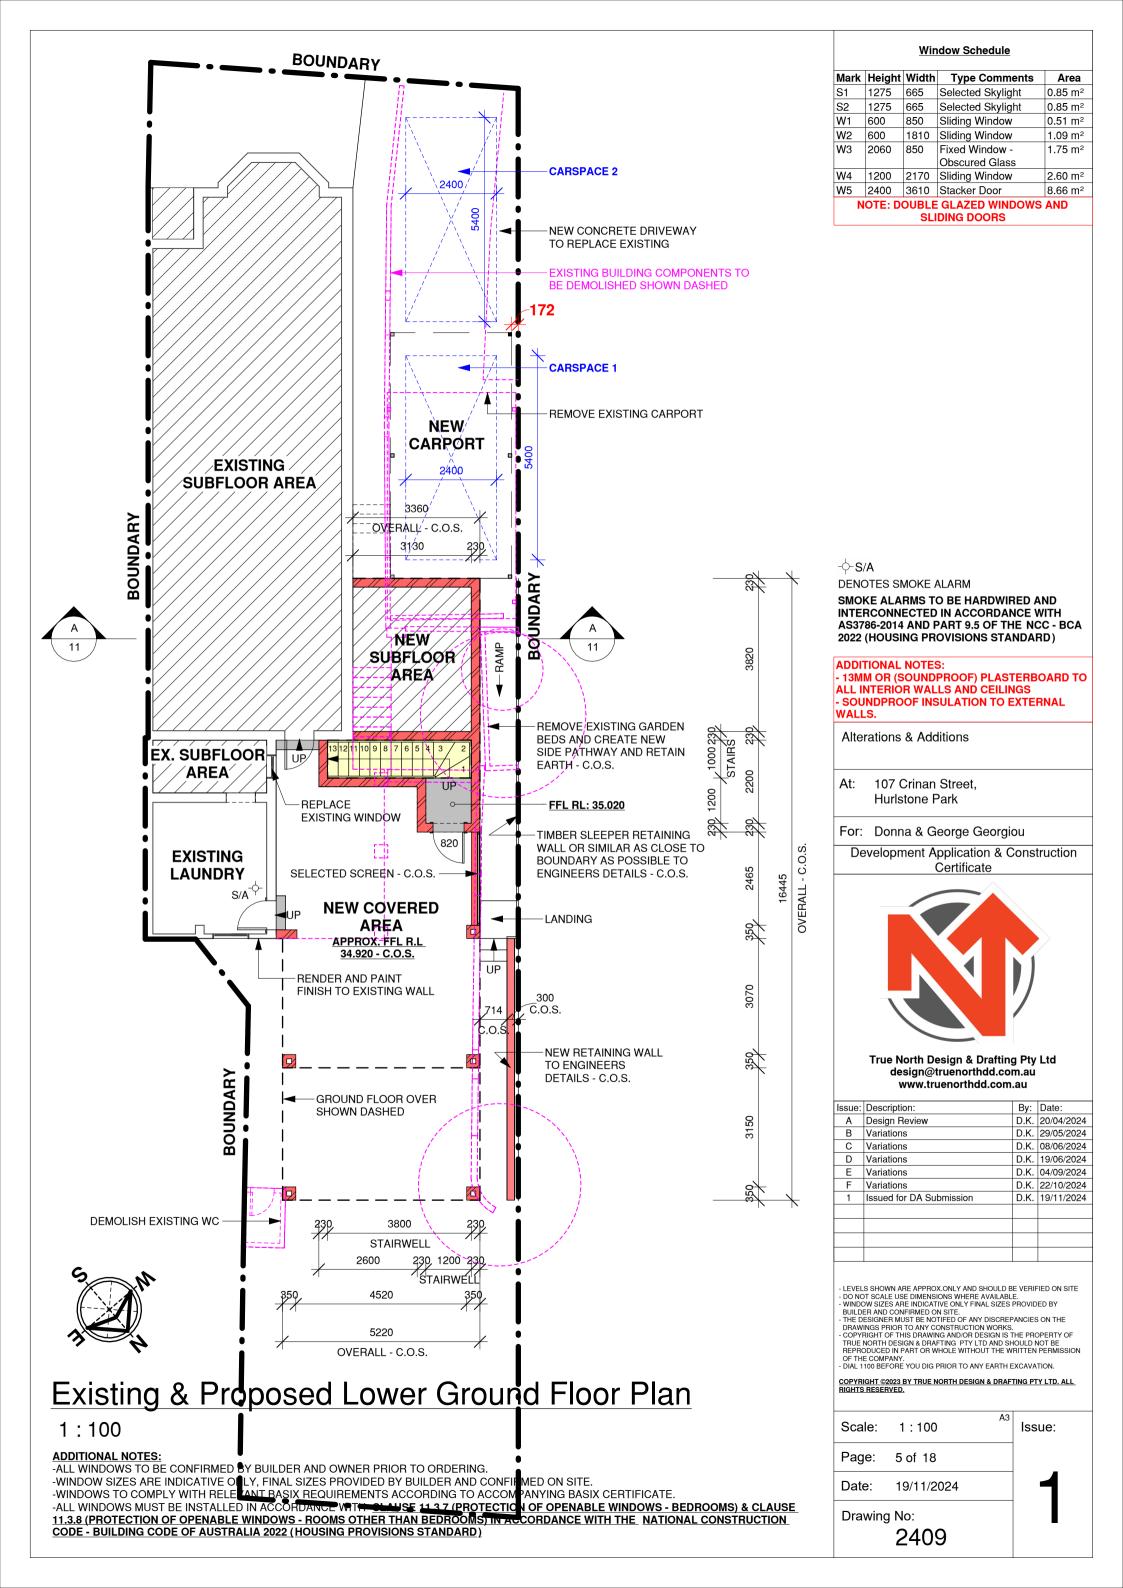

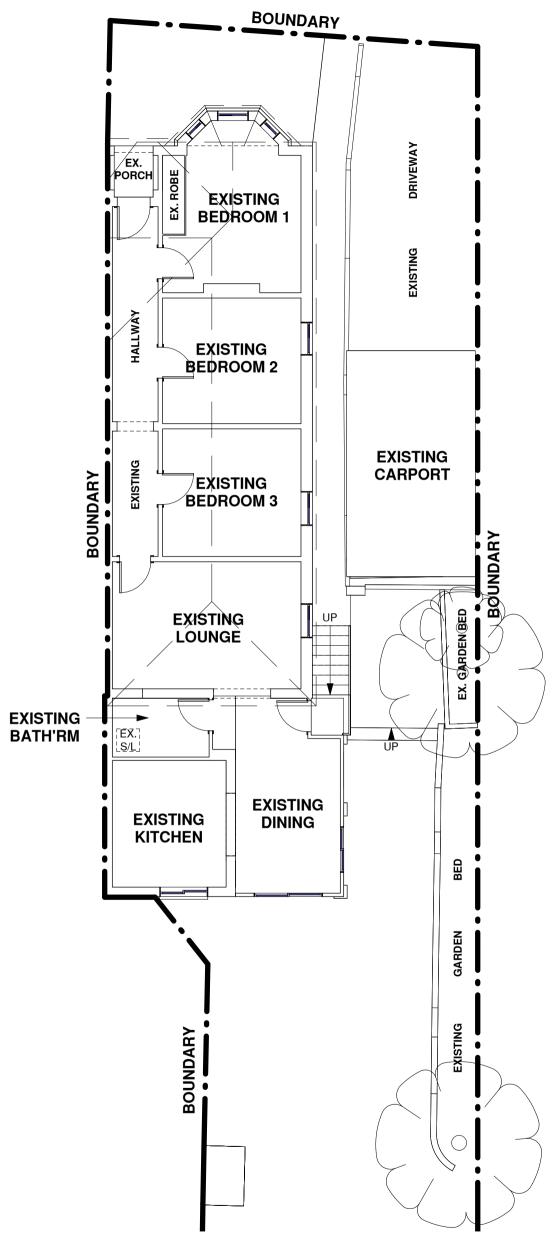



**Existing Ground Floor Plan** 

1:100

Alterations & Additions

107 Crinan Street, Hurlstone Park

For: Donna & George Georgiou

Development Application & Construction Certificate



True North Design & Drafting Pty Ltd design@truenorthdd.com.au www.truenorthdd.com.au


Issue:	Description:	By:	Date:
Α	Design Review	D.K.	20/04/2024
В	Variations	D.K.	29/05/2024
C	Variations	D.K.	08/06/2024
D	Variations	D.K.	19/06/2024
Е	Variations	D.K.	04/09/2024
F	Variations	D.K.	22/10/2024
1	Issued for DA Submission	D.K.	19/11/2024


- LEVELS SHOWN ARE APPROX.ONLY AND SHOULD BE VERIFIED ON SITE
- DO NOT SCALE USE DIMENSIONS WHERE AVAILABLE.
- WINDOW SIZES ARE INDICATIVE ONLY FINAL SIZES PROVIDED BY
BUILDER AND CONFIRMED ON SITE.
- THE DESIGNER MUST BE NOTIFED OF ANY DISCREPANCIES ON THE
DRAWINGS PRIOR TO ANY CONSTRUCTION WORKS.
- COPYPIGHT OF THIS DRAWING AND/OR DESIGN IS THE PROPERTY OF
TRUE NORTH DESIGN & DRAFTING PTY LTD AND SHOULD NOT BE
REPRODUCED IN PART OR WHOLE WITHOUT THE WRITTEN PERMISSION
OF THE COMPANY. OF THE COMPANY. - DIAL 1100 BEFORE YOU DIG PRIOR TO ANY EARTH EXCAVATION.


COPYRIGHT ©2023 BY TRUE NORTH DESIGN & DRAFTING PTY LTD. ALL RIGHTS RESERVED.


Issue:

1:100 Scale: Page: 6 of 18 Date: 19/11/2024 Drawing No: 2409

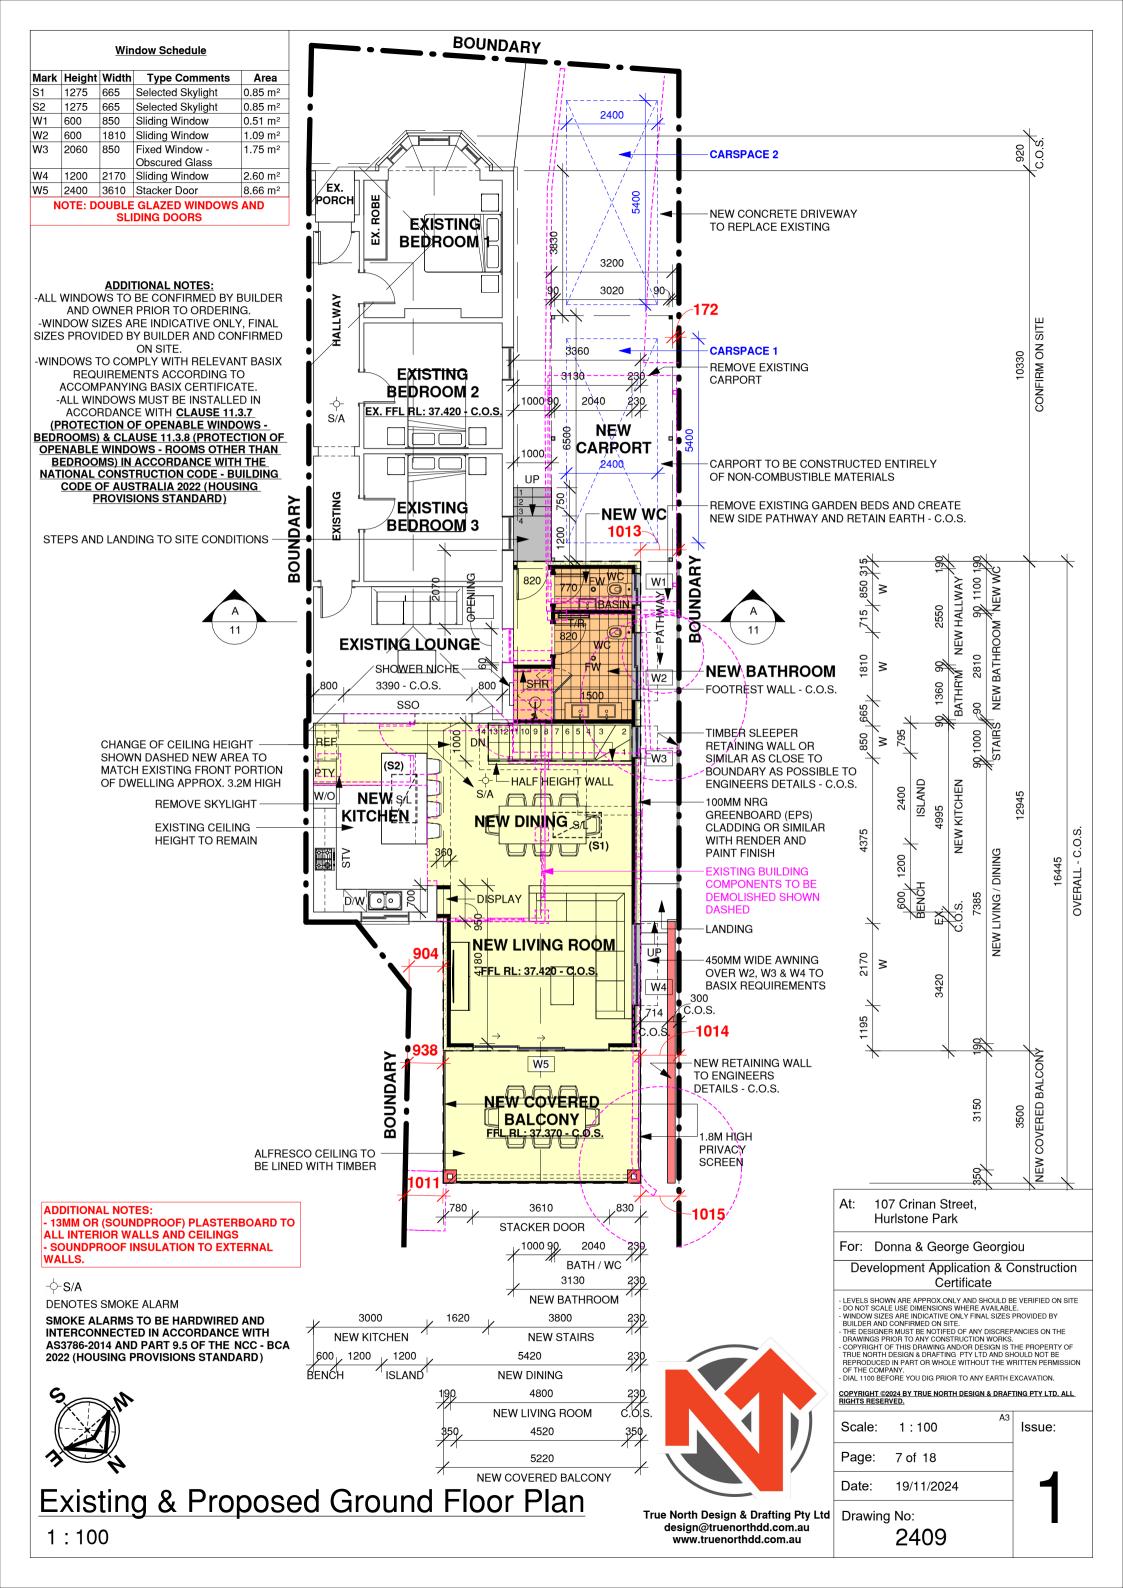

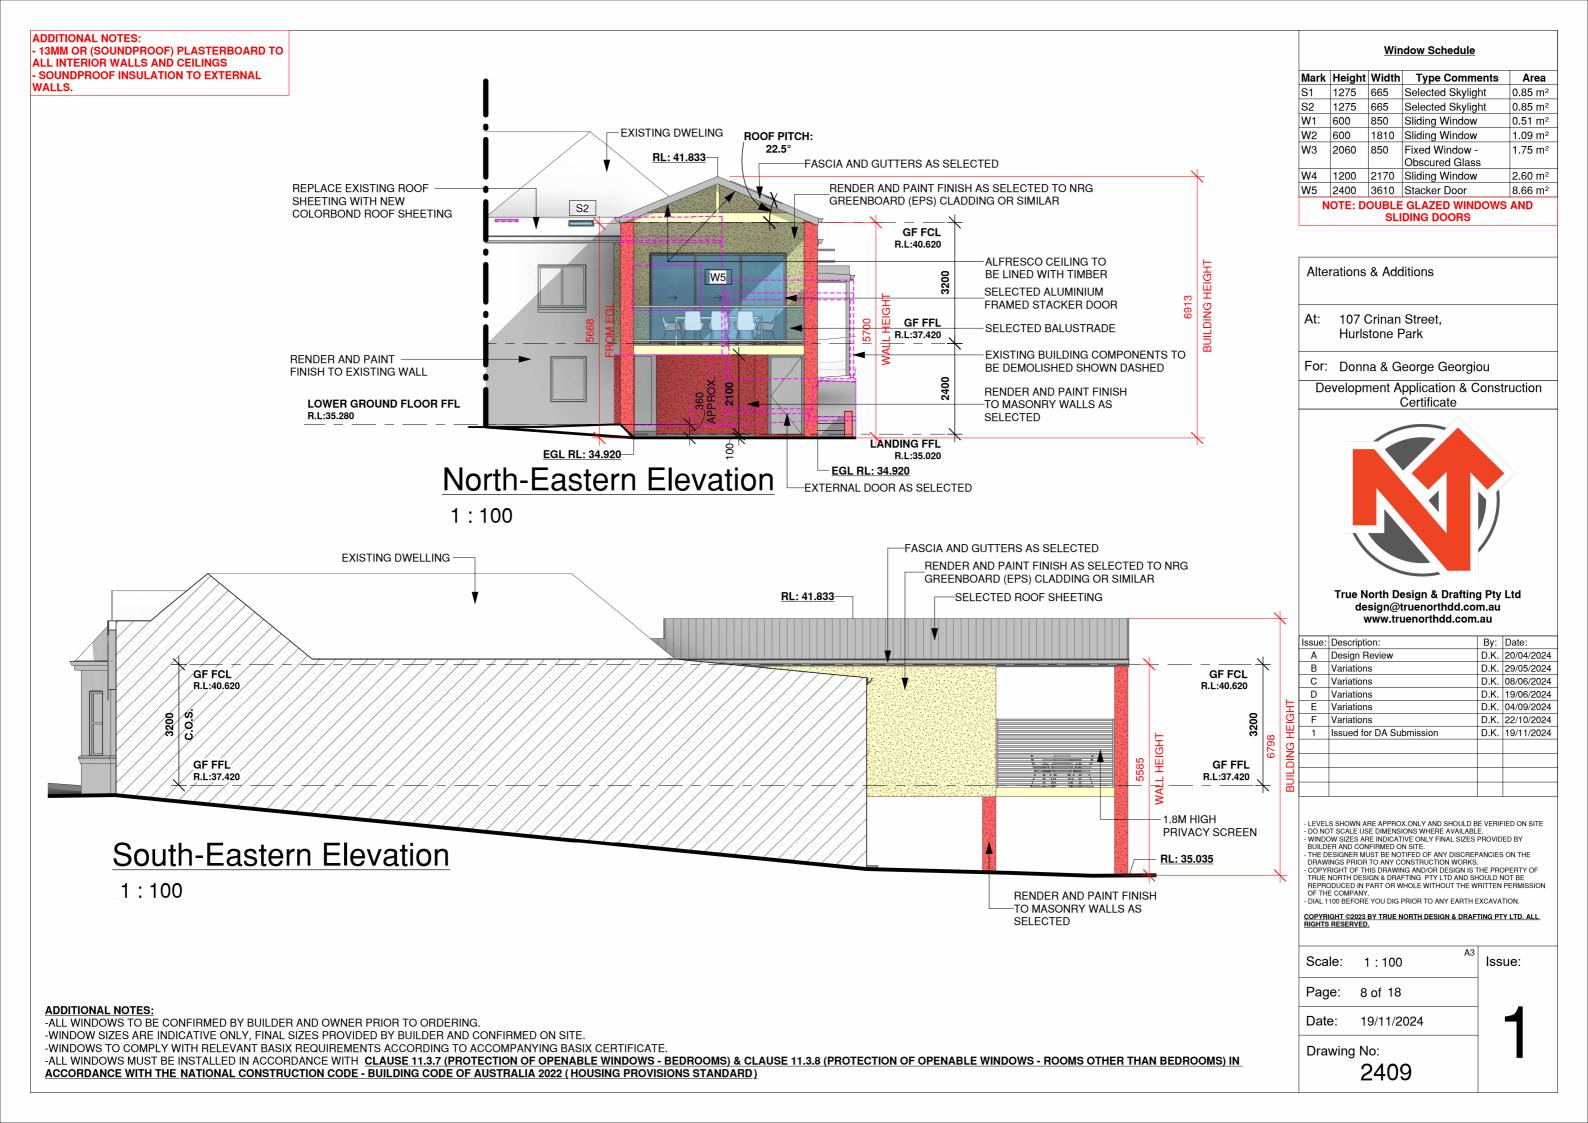

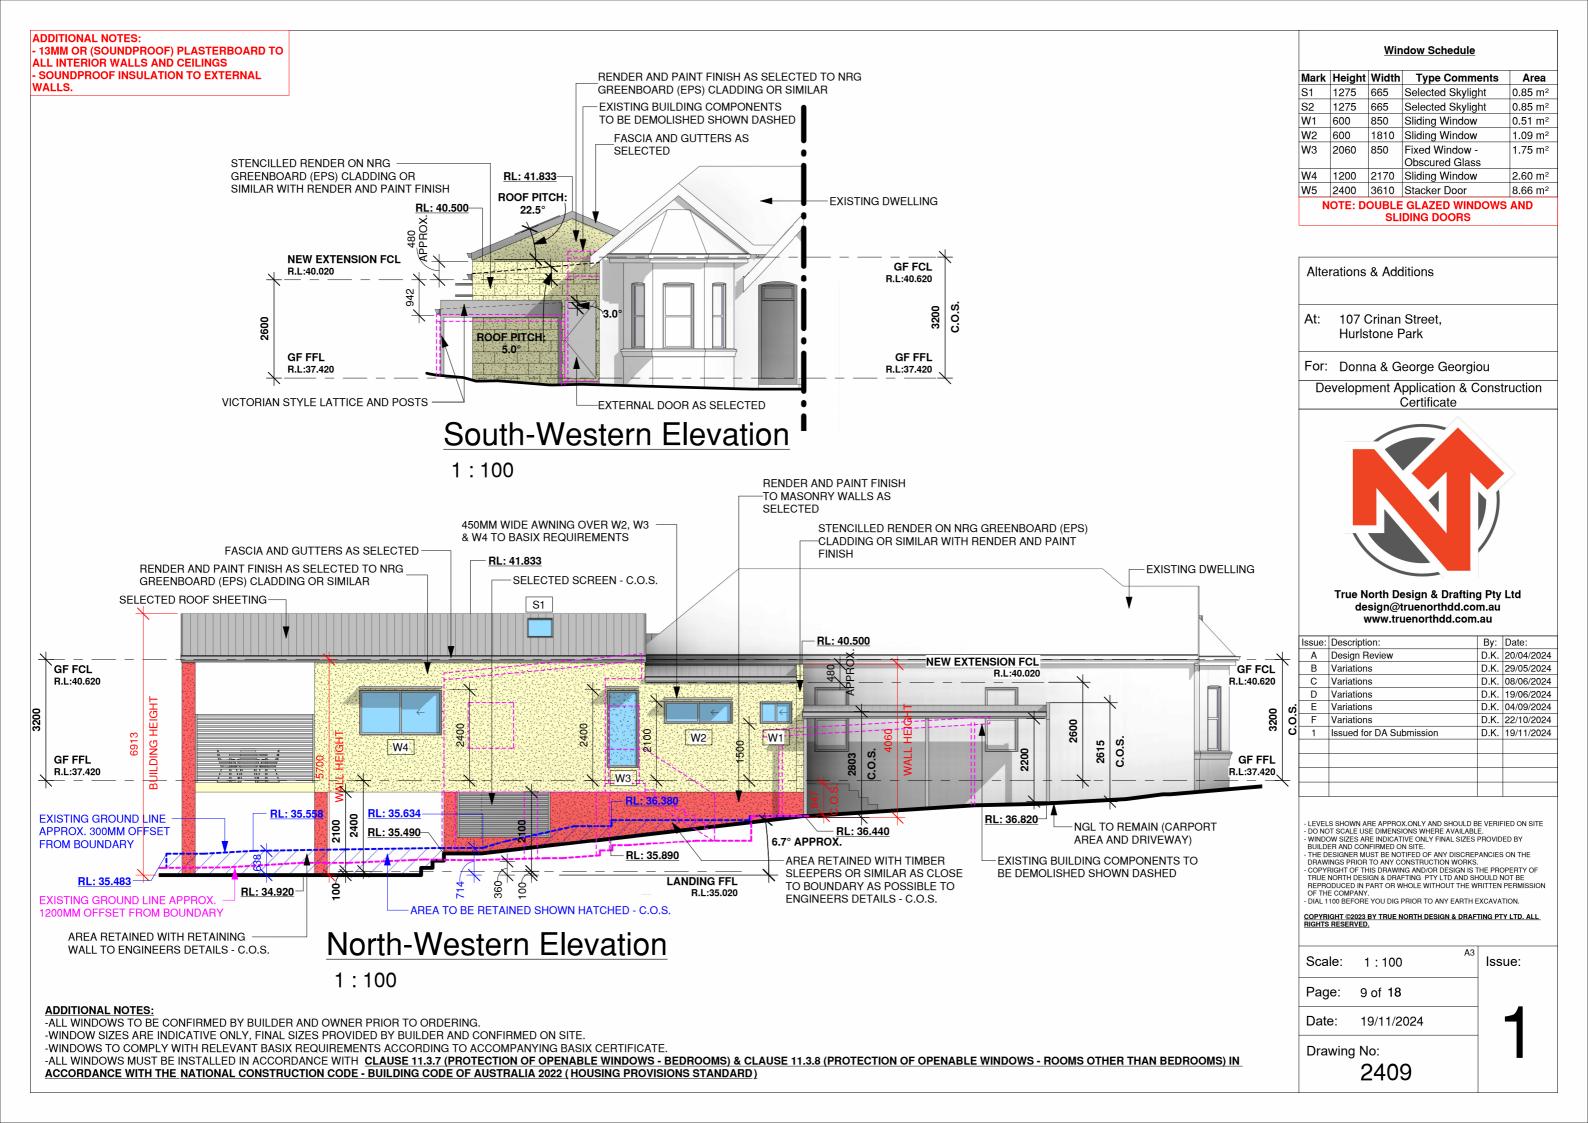

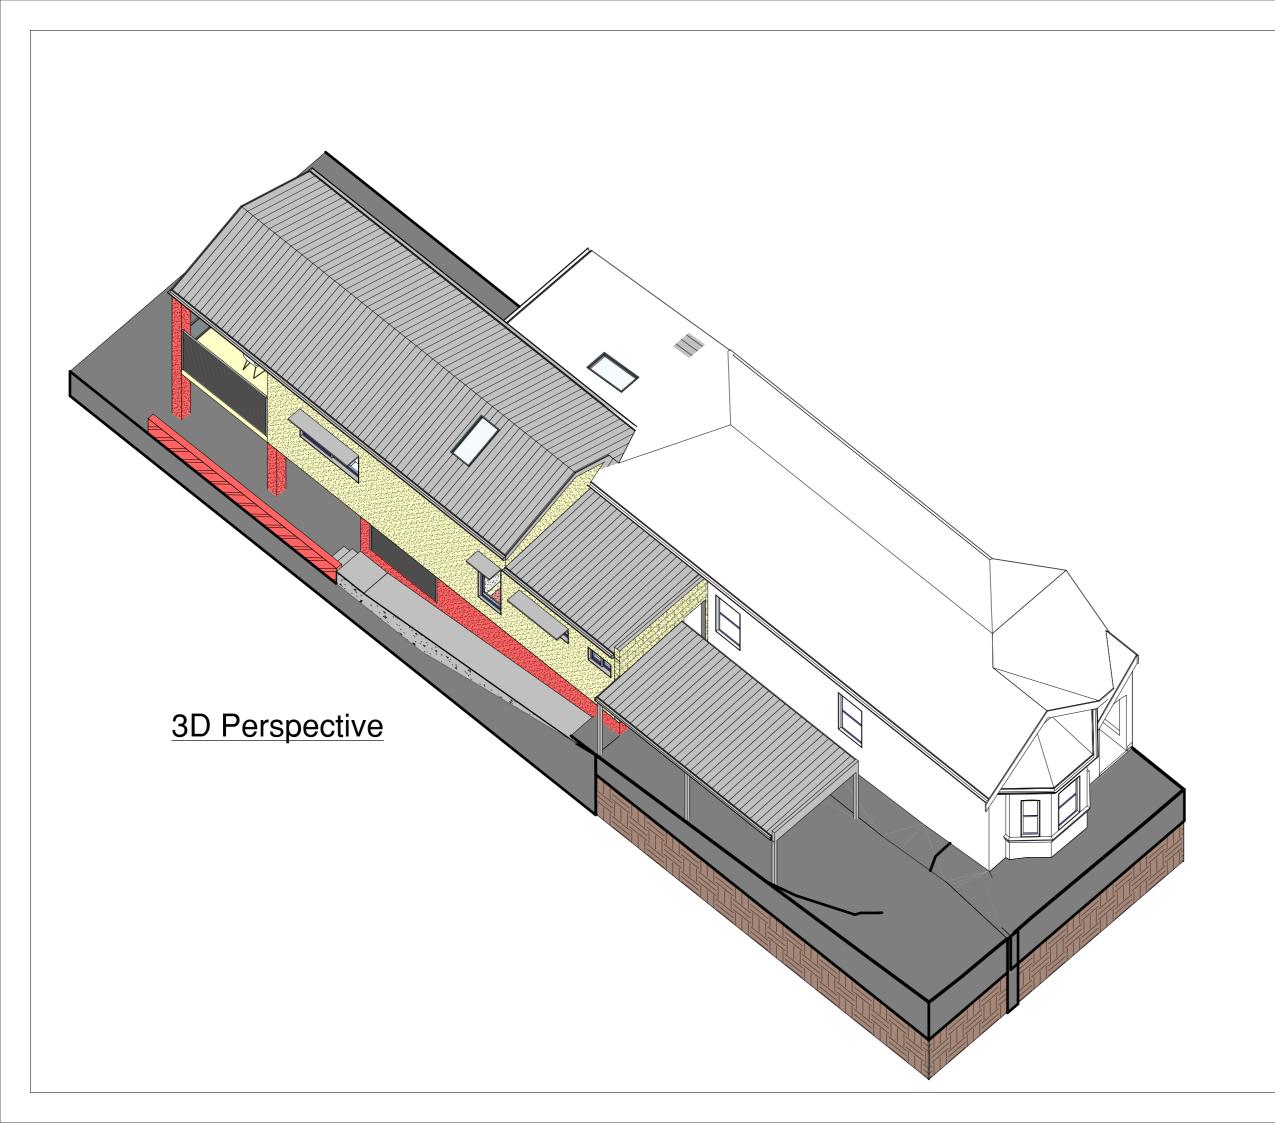

Alterations & Additions

At: 107 Crinan Street, Hurlstone Park

For: Donna & George Georgiou

Development Application & Construction Certificate



True North Design & Drafting Pty Ltd design@truenorthdd.com.au www.truenorthdd.com.au


Issue:	Description:	By:	Date:
Α	Design Review	D.K.	20/04/2024
В	Variations	D.K.	29/05/2024
С	Variations	D.K.	08/06/2024
D	Variations	D.K.	19/06/2024
E	Variations	D.K.	04/09/2024
F	Variations	D.K.	22/10/2024
1	Issued for DA Submission	D.K.	19/11/2024

- LEVELS SHOWN ARE APPROX.ONLY AND SHOULD BE VERIFIED ON SITE
   DO NOT SCALE USE DIMENSIONS WHERE AVAILABLE.
   WINDOW SIZES ARE INDICATIVE ONLY FINAL SIZES PROVIDED BY
  BUILDER AND CONFIRMED ON SITE.
   THE DESIGNER MUST BE NOTIFED OF ANY DISCREPANCIES ON THE
  DRAWINGS PRIOR TO ANY CONSTRUCTION WORKS.
   COPYRIGHT OF THIS DRAWING AND/OR DESIGN IS THE PROPERTY OF
  TRUE NORTH DESIGN & DRAFTING PTY LTD AND SHOULD NOT BE
  REPRODUCED IN PART OR WHOLE WITHOUT THE WRITTEN PERMISSION
  OF THE COMPANY.
   DIAL 1100 BEFORE YOU DIG PRIOR TO ANY EARTH EXCAVATION.

COPYRIGHT ©2023 BY TRUE NORTH DESIGN & DRAFTING PTY LTD. ALL RIGHTS RESERVED.

Scale: Issue: Page: 10 of18 Date: 19/11/2024

Drawing No:

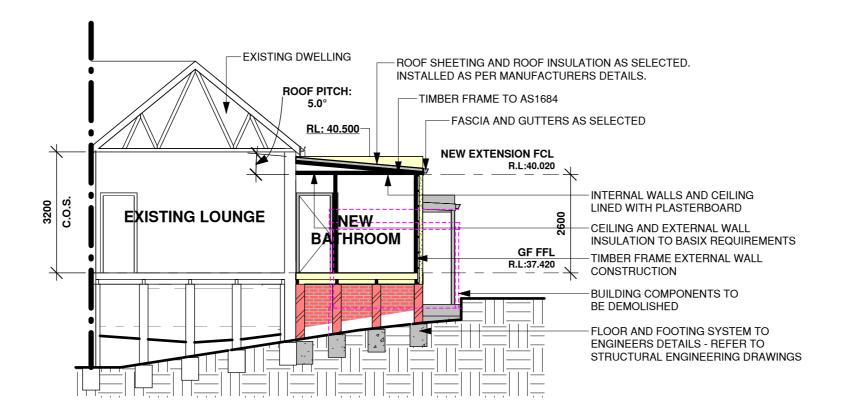

# Section A-A

1:100

Alterations & Additions

At: 107 Crinan Street, Hurlstone Park

For: Donna & George Georgiou

Development Application & Construction Certificate



True North Design & Drafting Pty Ltd design@truenorthdd.com.au www.truenorthdd.com.au

Issue:	Description:	By:	Date:
Α	Design Review	D.K.	20/04/2024
В	Variations	D.K.	29/05/2024
С	Variations	D.K.	08/06/2024
D	Variations	D.K.	19/06/2024
E	Variations	D.K.	04/09/2024
F	Variations	D.K.	22/10/2024
1	Issued for DA Submission	D.K.	19/11/2024

- LEVELS SHOWN ARE APPROX.ONLY AND SHOULD BE VERIFIED ON SITE
- DO NOT SCALE USE DIMENSIONS WHERE AVAILABLE.
- WINDOW SIZES ARE INDICATIVE ONLY FINAL SIZES PROVIDED BY
BUILDER AND CONFIRMED ON SITE.
- THE DESIGNER MUST BE NOTIFED OF ANY DISCREPANCIES ON THE
DRAWINGS PRIOR TO ANY CONSTRUCTION WORKS.
- COPYRIGHT OF THIS DRAWING AND/OR DESIGN IS THE PROPERTY OF
TRUE NORTH DESIGN & DRAFTING PTY LTD AND SHOULD NOT BE
REPRODUCED IN PART OR WHOLE WITHOUT THE WRITTEN PERMISSION
OF THE COMPANY.
- DIAL 1100 BEFORE YOU DIG PRIOR TO ANY EARTH EXCAVATION.

COPYRIGHT ©2023 BY TRUE NORTH DESIGN & DRAFTING PTY LTD. ALL RIGHTS RESERVED.


Scale: 1:100 Issue:


Page: 11 of18


Date: 19/11/2024


Drawing No:

### **Sediment Control Details**

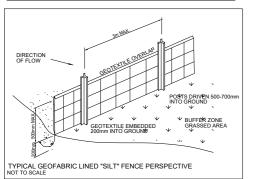

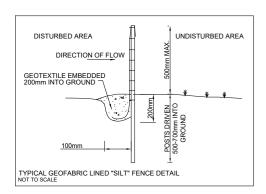

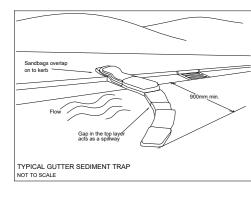

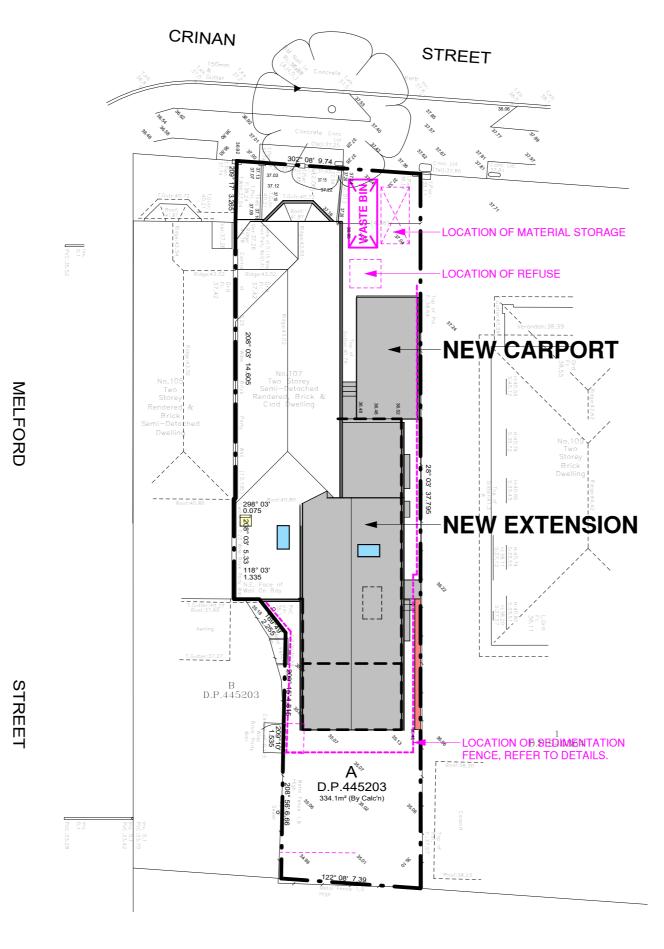



Waste Management & Sediment Control Plan

1:200

Alterations & Additions

At: 107 Crinan Street, Hurlstone Park

For: Donna & George Georgiou

Development Application & Construction Certificate



True North Design & Drafting Pty Ltd design@truenorthdd.com.au www.truenorthdd.com.au


Issue:	Description:	By:	Date:
Α	Design Review	D.K.	20/04/2024
В	Variations	D.K.	29/05/2024
С	Variations	D.K.	08/06/2024
D	Variations	D.K.	19/06/2024
E	Variations	D.K.	04/09/2024
F	Variations	D.K.	22/10/2024
1	Issued for DA Submission	D.K.	19/11/2024

- LEVELS SHOWN ARE APPROX.ONLY AND SHOULD BE VERIFIED ON SITE
- DO NOT SCALE USE DIMENSIONS WHERE AVAILABLE.
- WINDOW SIZES ARE INDICATIVE ONLY FINAL SIZES PROVIDED BY
BUILDER AND CONFIRMED ON SITE.
- THE DESIGNER MUST BE NOTIFED OF ANY DISCREPANCIES ON THE
DRAWINGS PRIOR TO ANY CONSTRUCTION WORKS.
- COPYRIGHT OF THIS DRAWING AND/OR DESIGN IS THE PROPERTY OF
TRUE NORTH DESIGN & DRAFTING PTY LTD AND SHOULD NOT BE
REPRODUCED IN PART OR WHOLE WITHOUT THE WRITTEN PERMISSION
OF THE COMPANY.
- DIAL 1100 BEFORE YOU DIG PRIOR TO ANY EARTH EXCAVATION.

COPYRIGHT ©2023 BY TRUE NORTH DESIGN & DRAFTING PTY LTD. ALL RIGHTS RESERVED.

Scale: As indicated Issue: Page: 12 of 18 Date: 19/11/2024

Drawing No:

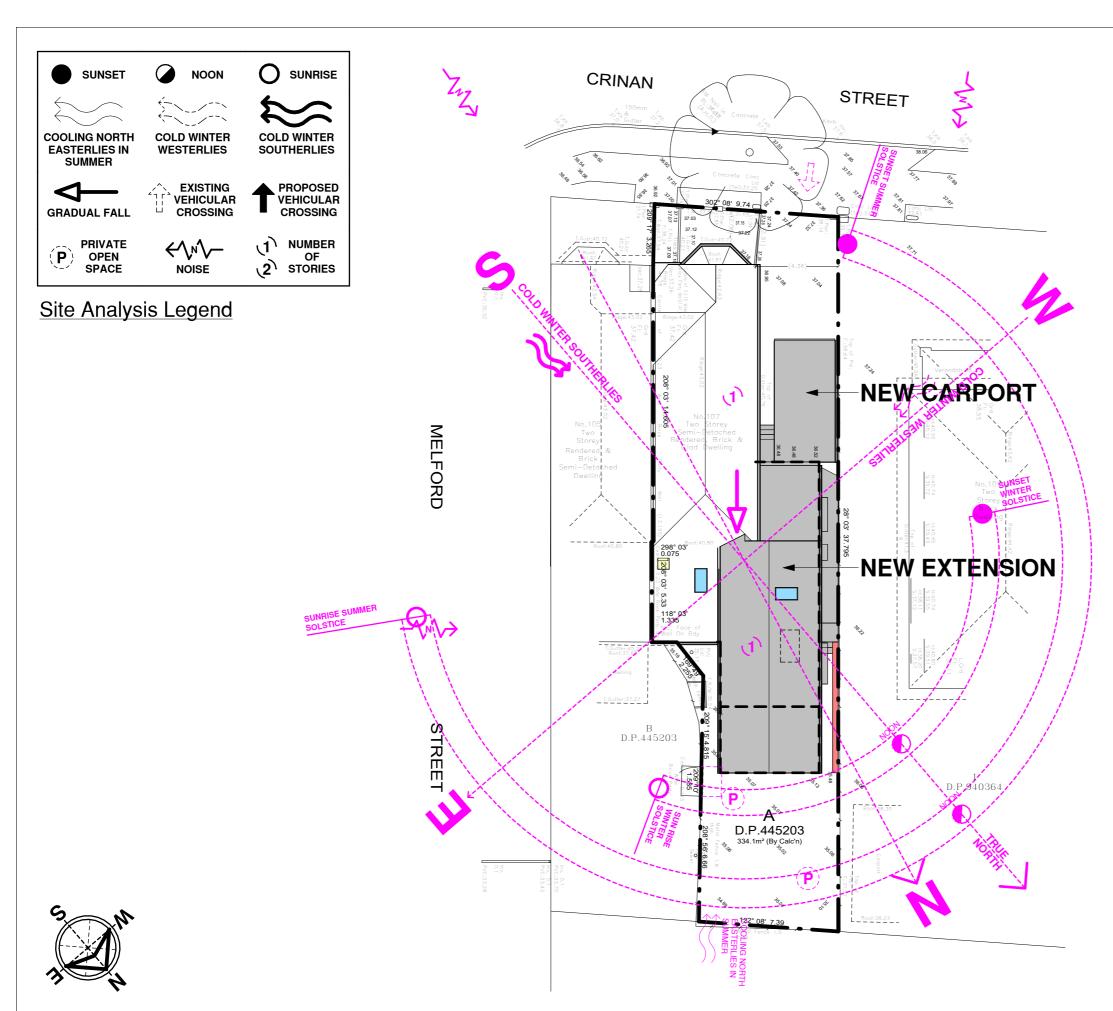

Alterations & Additions

At: 107 Crinan Street, Hurlstone Park

For: Donna & George Georgiou

Development Application & Construction Certificate



True North Design & Drafting Pty Ltd design@truenorthdd.com.au www.truenorthdd.com.au

Issue:	Description:	By:	Date:	
Α	Design Review	D.K.	20/04/2024	
В	Variations	D.K.	29/05/2024	
С	Variations	D.K.	08/06/2024	
D	Variations	D.K.	19/06/2024	
Е	Variations	D.K.	04/09/2024	
F	Variations	D.K.	22/10/2024	
1	Issued for DA Submission	D.K.	19/11/2024	

- LEVELS SHOWN ARE APPROX.ONLY AND SHOULD BE VERIFIED ON SITE
- DO NOT SCALE USE DIMENSIONS WHERE AVAILABLE.
- WINDOW SIZES ARE INDICATIVE ONLY FINAL SIZES PROVIDED BY
BUILDER AND CONFIRMED ON SITE.
- THE DESIGNER MUST BE NOTIFED OF ANY DISCREPANCIES ON THE
DRAWINGS PRIOR TO ANY CONSTRUCTION WORKS.
- COPYRIGHT OF THIS DRAWING AND/OR DESIGN IS THE PROPERTY OF
TRUE NORTH DESIGN & DRAFTING PTY LTD AND SHOULD NOT BE
REPRODUCED IN PART OR WHOLE WITHOUT THE WRITTEN PERMISSION
OF THE COMPANY.
- DIAL 1100 BEFORE YOU DIG PRIOR TO ANY EARTH EXCAVATION.

COPYRIGHT ©2023 BY TRUE NORTH DESIGN & DRAFTING PTY LTD. ALL RIGHTS RESERVED.

Scale: 1:200 Issue: Page: 13 of 18 Date: 19/11/2024

Drawing No:


2409

Site Analysis Plan

1:200


## **SHADOWS CAST ON JUNE 21**



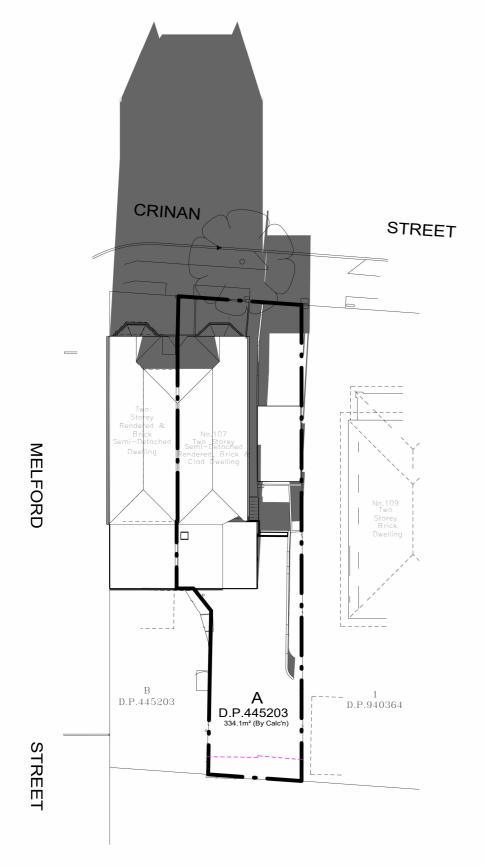

Existing 9am Shadow Diagram

1:300

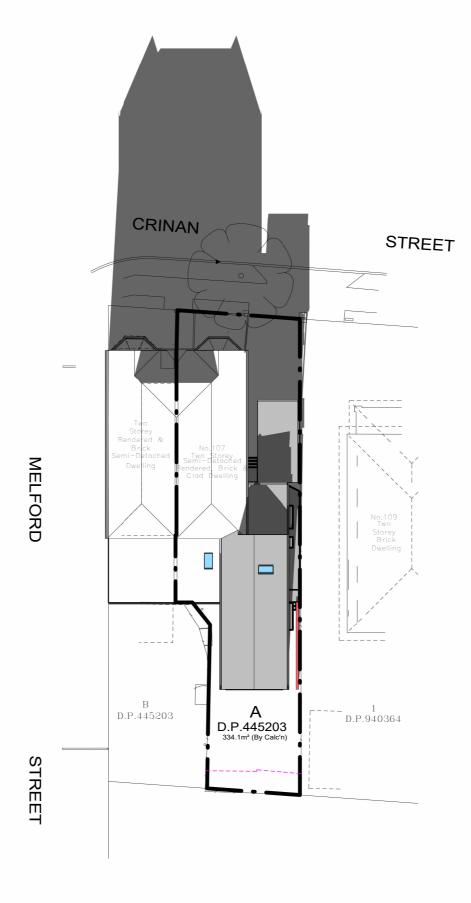

Proposed 9am Shadow Diagram

1:300

Alterations & Additions

At: 107 Crinan Street, Hurlstone Park

For: Donna & George Georgiou

Development Application & Construction Certificate



True North Design & Drafting Pty Ltd design@truenorthdd.com.au www.truenorthdd.com.au

Issue:	Description:	By:	Date:
Α	Design Review	D.K.	20/04/2024
В	Variations	D.K.	29/05/2024
С	Variations	D.K.	08/06/2024
D	Variations	D.K.	19/06/2024
Е	Variations	D.K.	04/09/2024
F	Variations	D.K.	22/10/2024
1	Issued for DA Submission	D.K.	19/11/2024

- LEVELS SHOWN ARE APPROX.ONLY AND SHOULD BE VERIFIED ON SITE - DO NOT SCALE USE DIMENSIONS WHERE AVAILABLE.
- WINDOW SIZES ARE INDICATIVE ONLY FINAL SIZES PROVIDED BY BUILDER AND CONFIRMED ON SITE.
- THE DESIGNER MUST BE NOTIFED OF ANY DISCREPANCIES ON THE DRAWINGS PRIOR TO ANY CONSTRUCTION WORKS.
- COPYRIGHT OF THIS DRAWING AND/OR DESIGN IS THE PROPERTY OF TRUE NORTH DESIGN & DRAFTING PTY LTD AND SHOULD NOT BE REPRODUCED IN PART OR WHOLE WITHOUT THE WRITTEN PERMISSION OF THE COMPANY.
- DIAL 1100 BEFORE YOU DIG PRIOR TO ANY EARTH EXCAVATION.

Scale: 1:300 Issue:

Page: 14 of 18


Date: 19/11/2024

2409

Drawing No:

## **SHADOWS CAST ON JUNE 21**



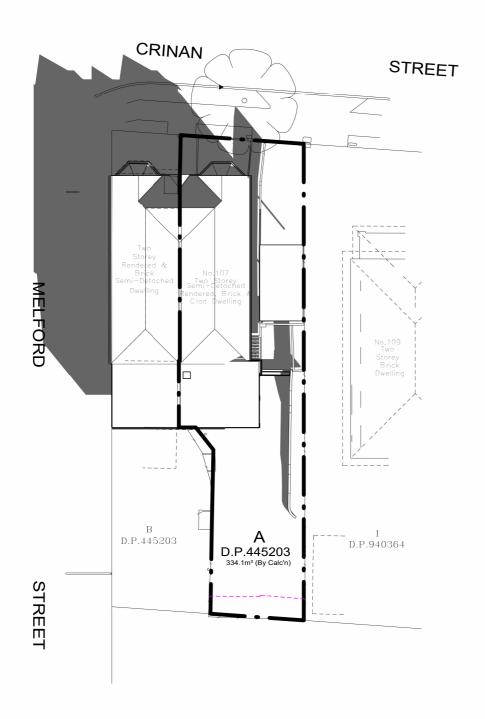

Existing 12pm Shadow Diagram 1:300

D.P.445203 D.P.940364 D.P.445203 STREET

STREET

CRINAN

Proposed 12pm Shadow Diagram 1:300

Alterations & Additions

At: 107 Crinan Street, Hurlstone Park

For: Donna & George Georgiou

Development Application & Construction Certificate



design@truenorthdd.com.au www.truenorthdd.com.au

Issue:	Description:	By:	Date:
Α	Design Review	D.K.	20/04/2024
В	Variations	D.K.	29/05/2024
С	Variations	D.K.	08/06/2024
D	Variations	D.K.	19/06/2024
Е	Variations	D.K.	04/09/2024
F	Variations	D.K.	22/10/2024
1	Issued for DA Submission	D.K.	19/11/2024

- LEVELS SHOWN ARE APPROX.ONLY AND SHOULD BE VERIFIED ON SITE - DO NOT SCALE USE DIMENSIONS WHERE AVAILABLE.
- WINDOW SIZES ARE INDICATIVE ONLY FINAL SIZES PROVIDED BY BUILDER AND CONFIRMED ON SITE.
- THE DESIGNER MUST BE NOTIFED OF ANY DISCREPANCIES ON THE DRAWINGS PRIOR TO ANY CONSTRUCTION WORKS.
- COPYRIGHT OF THIS DRAWING AND/OR DESIGN IS THE PROPERTY OF TRUE NORTH DESIGN & DRAFTING PTY LTD AND SHOULD NOT BE REPRODUCED IN PART OR WHOLE WITHOUT THE WRITTEN PERMISSION OF THE COMPANY.
- DIAL 1100 BEFORE YOU DIG PRIOR TO ANY EARTH EXCAVATION.

Scale: 1:300 Issue: 15 of 18 Page:

Date: 19/11/2024

Drawing No: 2409

### **SHADOWS CAST ON JUNE 21**





**Existing 3pm Shadow Diagram** 

1:300

1:300

Proposed 3pm Shadow Diagram

Alterations & Additions

At: 107 Crinan Street, Hurlstone Park

For: Donna & George Georgiou

Development Application & Construction Certificate



True North Design & Drafting Pty Ltd design@truenorthdd.com.au www.truenorthdd.com.au

Issue:	Description:	By:	Date:
Α	Design Review	D.K.	20/04/2024
В	Variations	D.K.	29/05/2024
С	Variations	D.K.	08/06/2024
D	Variations	D.K.	19/06/2024
Е	Variations	D.K.	04/09/2024
F	Variations	D.K.	22/10/2024
1	Issued for DA Submission	D.K.	19/11/2024

- LEVELS SHOWN ARE APPROX.ONLY AND SHOULD BE VERIFIED ON SITE - DO NOT SCALE USE DIMENSIONS WHERE AVAILABLE.
- WINDOW SIZES ARE INDICATIVE ONLY FINAL SIZES PROVIDED BY BUILDER AND CONFIRMED ON SITE.
- THE DESIGNER MUST BE NOTIFED OF ANY DISCREPANCIES ON THE DRAWINGS PRIOR TO ANY CONSTRUCTION WORKS.
- COPYRIGHT OF THIS DRAWING AND/OR DESIGN IS THE PROPERTY OF TRUE NORTH DESIGN & DRAFTING PTY LTD AND SHOULD NOT BE REPRODUCED IN PART OR WHOLE WITHOUT THE WRITTEN PERMISSION OF THE COMPANY.
- DIAL 1100 BEFORE YOU DIG PRIOR TO ANY EARTH EXCAVATION.

Scale:	1:300	<b>A</b> 3	Issue:
Page:	16 of 18		
Date:	19/11/2024		1
Drawing	No:		I
	<b>74</b> 03	- 1	



Alterations and Additions

Certificate number: A1773822\_02

This certificate confirms that the proposed development will meet the NSW government's requirements for sustainability, if it is built in accordance with the commitments set out below. Terms used in this certificate, or in the commitments, have the meaning given by the document entitled "BASIX Definitions" dated 10/09/2020 published by the Department. This document is available at www.basix.nsw.gov.au

Secretary
Date of issue: Friday, 21 February 2025
To be valid, this certificate must be lodged within 3 months of the date of issue.



Project name	107 Crinan Street, Hurlstone Park_02
Street address	107 CRINAN Street HURLSTONE PARK 2193
Local Government Area	Canterbury-Bankstown Council
Plan type and number	Deposited Plan DP445203
Lot number	A
Section number	12
Project type	
Dwelling type	Dwelling house (attached)
Type of alteration and addition	The estimated development cost for my renovation work is \$50,000 or more, and does not include a pool (and/or spa).
N/A	N/A
Certificate Prepared by (pl	ease complete before submitting to Council or PCA)
Name / Company Name: TDUE NO	RTH DESIGN & DRAFTING PTY LTD

ixtures and systems			Show on DA Plans	Show on CC/CDC Plans & specs	Certifier Check
ighting					
he applicant must ensure a minimum of 40 mitting-diode (LED) lamps.	% of new or altered light fixtures are fitted w	with fluorescent, compact fluorescent, or light-		¥	~
ixtures			-		
he applicant must ensure new or altered s	howerheads have a flow rate no greater than	n 9 litres per minute or a 3 star water rating.		~	~
he applicant must ensure new or altered to ating.	ilets have a flow rate no greater than 4 litres	s per average flush or a minimum 3 star water		~	~
he applicant must ensure new or altered to	ps have a flow rate no greater than 9 litres	per minute or minimum 3 star water rating.		~	
onstruction			Show on DA Plans	Show on CC/CDC Plans & specs	Certifier Check
nsulation requirements he applicant must construct the new or alt		ps/roofs) in accordance with the specifications rea of new construction is less than 2m2, b)	JA Hans	J	-
nsulation requirements the applicant must construct the new or alto sted in the table below, except that a) add		rea of new construction is less than 2m2, b)		~	~
nsulation requirements the applicant must construct the new or alto sted in the table below, except that a) add	itional insulation is not required where the a	rea of new construction is less than 2m2, b)		~	~
nsulation requirements  the applicant must construct the new or allosted in the table below, except that a) add insulation specified is not required for parts	itional insulation is not required where the a of altered construction where insulation alre Additional insulation required (R-	rea of new construction is less than 2m2, b) eady exists.		~	~
nsulation requirements  the applicant must construct the new or altested in the table below, except that a) add insulation specified is not required for parts  Construction  suspended floor with open subfloor:	itional insulation is not required where the a of altered construction where insulation already additional insulation required (R-value)  R0.8 (down) (or R1.50 including	rea of new construction is less than 2m2, b) eady exists.  Other specifications		~	~
nsulation requirements  the applicant must construct the new or altosted in the table below, except that a) addiniculation specified is not required for parts  Construction  suspended floor with open subfloor: framed (R0.7).  suspended floor with enclosed subfloor:	itional insulation is not required where the a of altered construction where insulation alread additional insulation required (R-value)  R0.8 (down) (or R1.50 including construction)  R0.60 (down) (or R1.30 including	rea of new construction is less than 2m2, b) eady exists.  Other specifications  N/A		~	~
nsulation requirements he applicant must construct the new or altosted in the table below, except that a) addinsulation specified is not required for parts  Construction  suspended floor with open subfloor: framed (R0.7).  suspended floor with enclosed subfloor: framed (R0.7).	Additional insulation is not required where the a of altered construction where insulation alread additional insulation required (R-value)  R0.8 (down) (or R1.50 including construction)  R0.60 (down) (or R1.30 including construction)	rea of new construction is less than 2m2, b) eady exists.  Other specifications  N/A  N/A		~	~
nsulation requirements he applicant must construct the new or altisted in the table below, except that a) add insulation specified is not required for parts  Construction  suspended floor with open subfloor: framed (R0.7).  suspended floor with enclosed subfloor: framed (R0.7).  floor above existing dwelling or building. external wall: external insulated façade	Additional insulation is not required where the a of altered construction where insulation alread additional insulation required (R-value)  R0.8 (down) (or R1.50 including construction)  R0.60 (down) (or R1.30 including construction)	rea of new construction is less than 2m2, b) eady exists.  Other specifications  N/A  N/A		~	~

	blanket (55 mm)	0.70)			
Glazing requirements			Show on DA Plans	Show on CC/CDC Plans & specs	Certifier Check
Windows and glazed doors					
The applicant must install the windows, glabelow. Relevant overshadowing specificat		accordance with the specifications listed in the todow and glazed door.	table	~	V
The following requirements must also be s	atisfied in relation to each window	and glazed door:		~	~
must have a U-value and a Solar Heat Ga	in Coefficient (SHGC) no greater thance with National Fenestration Ra	or clear/air gap/clear glazing, or toned/air gap/clea han that listed in the table below. Total system U ating Council (NFRC) conditions. The description ad SHGC may be substituted.	-values	~	~
For projections described in millimetres, th 500 mm above the head of the window or		ola, verandah, balcony or awning must be no mo 00 mm above the sill.	re than	~	~
For projections described as a ratio, the ra at least that shown in the table below.	tio of the projection from the wall to	the height above the window or glazed door sill	must be	~	~
Pergolas with polycarbonate roof or similar	translucent material must have a	shading coefficient of less than 0.35.		<b>V</b>	~
Pergolas with fixed battens must have batt also shades a perpendicular window. The		ed door above which they are situated, unless the tobe more than 50 mm.	e pergola	~	~

	zed doors glazing	requirements					DA Plans	Plans & specs	Chec
Window/door number	Orientation	Area of glass including frame (m2)	Overshadowing height (m)	Overshadowing distance (m)	Shading device	Frame and glass type			
W1	NW	0.51	0	0	none	standard aluminium, clear/air gap/ clear, (U-value: 5.34, SHGC: 0.67)			
W2	NW	1.09	0	0	eave/ verandah/ pergola/balcony >=450 mm	improved aluminium, toned/air gap/ clear, (U-value: 4.09, SHGC: 0.47)			
W3	NW	1.75	0	0	eave/ verandah/ pergola/balcony >=450 mm	improved aluminium, toned/air gap/ clear, (U-value: 4.09, SHGC: 0.47)			
W4	NW	2.6	0	0	eave/ verandah/ pergola/balcony >=450 mm	improved aluminium, toned/air gap/ clear, (U-value: 4.09, SHGC: 0.47)			
W5	NE	8.66	0	0.	projection/ height above sill ratio >=0.43	standard aluminium, clear/air gap/ clear, (U-value: 5.34, SHGC: 0.67)			
Glazing requir	rements						Show on DA Plans	Show on CC/CDC Plans & specs	Certif Chec
							T		
Skylights								1	1
The applicant mus	50.551	ts in accordance with			low.		~	~	v
The applicant mus	50.551	ts in accordance with			low.		~	· ·	•
The applicant mus	either match the d		ion to each skylight.	V V		eater than that	-	· · ·	
The applicant mus The following requ Each skylight may listed in the table	either match the d	be satisfied in relati	ion to each skylight.	V V		eater than that	•	7	
The applicant mus The following reques	either match the d below.	be satisfied in relati	on to each skylight	V V				· ·	
The applicant must The following required the following required the following required the following following the following	either match the d below. requirements	b be satisfied in relations or, have a secription, or, have a secription or, have a secription or secreption or se	on to each skylight	ar Heat Gain Coeffic g device	Frame and	glass type E internal/argon emal, (or U-value:		•	
The applicant mus  The following required in the table skylight may listed in the table skylights glazing  Skylight number	either match the d below.  requirements  er  0	be satisfied in relative escription, or, have a avea of glazing inc. m2)	ion to each skylight. a U-value and a Sol	ar Heat Gain Coeffic ig device ding	Frame and timber, low-fill/clear exte 2.9, SHGC: timber, low-fill/clear exte	glass type  E internal/argon emal, (or U-value: 0.456) E internal/argon emal, (or U-value:		~	
The applicant mus The following requ Each skylight may listed in the table Skylights glazing Skylight number S1	either match the d below.  requirements  er  A  0	escription, or, have a escription, or, have a Area of glazing inc. m2)	on to each skylight. a U-value and a Sol frame Shadin no sha	ar Heat Gain Coeffic ig device ding	Frame and timber, low-fill/clear exte 2.9, SHGC: timber, low-fill/clear exte	glass type  E internal/argon emal, (or U-value: 0.456) E internal/argon emal, (or U-value:		•	•
The applicant mus The following requ Each skylight may listed in the table Skylights glazing Skylight number S1 S2	either match the d below.  requirements  er  A  0	escription, or, have a escription, or, have a Area of glazing inc. m2)	frame Shadir no sha	ar Heat Gain Coeffic ig device ding	Frame and timber, low-fill/clear exte 2.9, SHGC: timber, low-fill/clear exte	glass type  E internal/argon emal, (or U-value: 0.456) E internal/argon emal, (or U-value:		~	~
The applicant mus The following requ Each skylight may listed in the table Skylights glazing Skylight number S1 S2  egend In these commitments iden	either match the dibelow.  requirements	escription, or, have a  Area of glazing inc. m2)  0.85	frame Shadir no sha no sha ying out the developms" column must be	ar Heat Gain Coeffic g device ding	Frame and timber, low- fill/clear exte 2.9, SHGC:	glass type E internal/argon emal, (or U-value: 0.456) E internal/argon emal, (or U-value: 0.456)		oroposed development (	v v

Alterations & Additions

At: 107 Crinan Street, Hurlstone Park

For: Donna & George Georgiou

Development Application & Construction Certificate



#### True North Design & Drafting Pty Ltd design@truenorthdd.com.au www.truenorthdd.com.au

Issue:	Description:	By:	Date:
Α	Design Review	D.K.	20/04/2024
В	Variations	D.K.	29/05/2024
С	Variations	D.K.	08/06/2024
D	Variations	D.K.	19/06/2024
Е	Variations	D.K.	04/09/2024
F	Variations	D.K.	22/10/2024
1	Issued for DA Submission	D.K.	19/11/2024
	I .		i

- LEVELS SHOWN ARE APPROX.ONLY AND SHOULD BE VERIFIED ON SITE
- DO NOT SCALE USE DIMENSIONS WHERE AVAILABLE.
- WINDOW SIZES ARE INDICATIVE ONLY FINAL SIZES PROVIDED BY
BUILDER AND CONFIRMED ON SITE.
- THE DESIGNER MUST BE NOTIFED OF ANY DISCREPANCIES ON THE
DRAWINGS PRIOR TO ANY CONSTRUCTION WORKS.
- COPYRIGHT OF THIS DRAWING AND/OR DESIGN IS THE PROPERTY OF
TRUE NORTH DESIGN & DRAFTING PTY LTD AND SHOULD NOT BE
REPRODUCED IN PART OR WHOLE WITHOUT THE WRITTEN PERMISSION
OF THE COMPANY.
- DIAL 1100 BEFORE YOU DIG PRIOR TO ANY EARTH EXCAVATION.

COPYRIGHT ©2023 BY TRUE NORTH DESIGN & DRAFTING PTY LTD. ALL RIGHTS RESERVED.

Scale: Page: 17 of 18 19/11/2024 Date:

Drawing No:

2409

Issue:

#### **General Notes**

Refer to and coordinate information contained in the architectural drawings, and the documentation of other consultants. Notify any discrepancies between the architectural and/or other consultants documentation prior to proceeding with the works.

#### **Specifications and Schedules**

Refer to and coordinate with applicable Specifications and Schedules. Notify any discrepancies between documents prior to proceeding with the works.

#### Detail Drawings

Drawings at larger scales take precedence over drawings at smaller scales, Notify any discrepancies prior to proceeding with the works.

#### Execution of the works

Execute the works in accordance and compliance

- The approved Development Application and in accordance with the relevant Conditions of Consent and other relevant Local Authority requirements; - The requirements scheduled by a current BASIX Certificate consistent with the works.
- The current edition of the Building Code of Australia (as amended); and
- Current editions of the relevant Australian and other applicable published standards relevant to the execution of the works.

#### Units of measurement

Dimensions are shown in millimetres unless noted

#### Materials handling and storage

Material, fixtures and fittings are to be handled, stored and installed in accordance with the Manufacturer's current written instructions.

#### Structure

Foundations, footings, reinforced concrete slabs, retaining walls, framing, bracing, tie-down and other structural elements are to be constructed in accordance with the Structural Engineer's details and specifications.

#### **Hydraulics**

Stormwater drainage, waste water drainage, fresh water, gas supply and other hydraulic services are to be constructed in accordance with Local Authority and Hydraulic Engineer's requirements.

### **Specification Notes**

#### General Specifications

Execute the works in compliance with the relevant deemed-to-satisfy provisions of the National Construction Code (NCC) - Building Code of Australia (BCA) 2022 (Volume 2 & Housing Provisions Standard), current editions of relevant Australian and other applicable published Standards and the relevant requirements of Local and/or Statutory Authorities applicable to the execution of the works. This schedule of codes and standards outlines the minimum acceptable standards.

#### Termite protection

Provide termite protection: In accordance with Part H1D3 'Site preparation' of the NCC - BCA 2022 (Volume 2) and Part 3.4 'Termite Risk Management' of the NCC - BCA 2022 (Housing Provisions Standard) and to AS 3660 1 (Termite management - New building work) Provide professional certification of the termite protection measures to the principal certifying authority, confirming compliance with the provisions of the BCA and Australian Standard.

Flashing and damp-proof courses Flashings and damp-proof courses: To AS/NZS 2904 (Damp proof courses and flashings) Fasteners

Steel nails: Hot-dip galvanised to AS/NZS 4680 (Hot-dip glavanised (zinc) coatings on fabricated ferrous articles).

Self-drilling screws: To AS 3566.1 (Self-drilling screws for the building and construction industries) Metal finishes

Corrosion protection: To NCC - BCA 2022 (Housing Provisions Standard) clause 6.3.9 'Corrosion Protection'

#### Site Preparation

Demolition

Demolish existing structures as shown: To AS 2601 (Demolition of structures).

Earthworks

To be carried out in accordance with: The requirements of the Environmental Planning & Assessment Act 1979:

Relevant conditions of the development consent; and the relevant requirements of Part H1D3 'Site Preparation' of the NCC - BCA 2022 (Volume 2) and Part 3.2 'Earthworks' of the NCC - BCA 2022 (Housing Provisions Standard). <u>Drainage</u>

Part H2D2 'Drainage' of the NCC - BCA 2022 (Volume 2), Part 3.3 'Drainage' of the NCC - BCA 2022 (Housing Provisions Standard) and AS/NZS 3500 (Part 3 - Stormwater drainage). AS/NZS 3500 (Part 5 - Domestic installations -Section 5 - stormwater drainage).

#### Structural design

For details of structural footings, slabs, framing and the like refer to structural engineering details, to be prepared by a qualified structural engineer. Structural design is to be in accordance with the relevant structural design manuals.

Site Classification

To be in accordance with Part 4.2.2 of the NCC -BCA 2022 (Housing Provisions Standard) Structural design manuals AS 1170.1 (Dead and live loads and load combinations)

AS 1170.2 (AS 4055 - Wind loads) AS 1170.4 (Earthquake loads)

AS 1720.1 (Timber structures code) AS 2159 (Piling - design and installation) AS 2327.1 (Composite structures)

AS 3600 (Concrete structures) AS 4100 (Steel structures)

Structural design certification

Submit structural engineer's design certification, in accordance with Local Authority requirements, the Principal Certifying Authority prior to the commencement of works.

#### Concrete construction

Concrete structures generally: To AS 3600 (Concrete structures). Ground Slabs and footings: To AS 2870 (Residential slabs and footings - Construction). Ready mixed supply: To AS 1379 (Specification and supply of concrete).

Footings and slabs Design and construct footings and slabs: In accordance with Part H1D4 'Footings and slabs' of the NCC - BCA 2022 (Volume 2), Part 4.1 'Scope and application of section 4' & 4.2 'Footings, slabs and associated elements' of the NCC - BCA 2022 (Housing Provisions Standard) and AS 2870 (Residential slabs and footings), AS 3600 (Concrete structures) and AS 2159 (Piling - Design and installation).

#### Brick & block construction (masonry)

Masonry construction: To be in accordance with Part H1D5 'Masonry' and H2D4 'Masonry' of the NCC - BCA 2022 (Volume 2), Part 5.1 'Scope and application of Section 5', Part 5.2 'Masonry Veneer', Part 5.3 'Cavity Masonry', Part 5.4 'Unreinforced single leaf masonry', Part 5.5 'Isolated masonry piers', Part 5.6 'Masonry components and accessories' and Part 5.7 'Weatherproofing of masonry' of the NCC - BCA 2022 (Housing Provisions Standard). Also in accordance to to AS 3700 (Masonry structures). Masonry units: To AS/NZS 4455 (Masonry units

and segmental payers) Clay brick durability below damp-proof course: Use exposure category to AS/NZS 4456.10 (Masonry units and segmental pavers - Methods of test - Determining resistance to salt attack) Appendix A (Salt attack resistance categories).

#### Galvanising

Galvanising mild steel components (including fasteners) to AS 1214 or AS/NZS 4680, as appropriate, where exposed to weather, embedded in masonry or in contact with chemically treated

Wall Ties to Part 5.6.5 'Wall ties'of the NCC - BCA 2022 (Housing Provisions Standard) and AS/NZS 2699.1 (Built-in components for masonry construction - Wall ties); Non-seismic areas: Type A; Seismic areas: Type B.

Wall tie spacing: to NCC - BCA 2022 (Housing Provisions Standard) Table 5.6.5a 'Wall tie spacingsin masonry veneer' and Table 5.6.5b 'Wall tie spacing in cavity and solid masonry'. Placement of wall ties to NCC - BCA 2022 (Housing

Provisions Standard) Table 5.6.5c 'Placement of Wall tie corrosion protection to NCC - BCA 2022

(Housing Provisions Standard) Table 5.6.5d 'Corrosion protection for wall ties'. Lintels in accordance with Part 5.2.3 'Openings in masonry veneer' & 5.6.7 'Lintels' of the NCC - BCA 2022 (Housing Provisions Standard).

#### Timber & steel framed construction

Framing to Part H1D6 'Framing' of the NCC - BCA 2022 (Volume 2) and Part 6.1 'Scope and application of Section 6' of the NCC - BCA 2022 (Housing Provisions Standard) Sub-floor ventilation

To be in accordance with Part H2D5 'Subfloor ventilation' of the NCC - BCA 2022 (Volume 2) and Part 6.2 'Subfloor ventilation' of the NCC - BCA 2022 (Housing Provisions Standard). Timber wall, floor and roof framing Timber framing: To be in accordance with Part H1D6 'Framing' of the NCC - BCA 2022 (Volume 2)

AS 1684.4 (Residential timber-framed construction - Simplified - Non-cyclonic) or AS 1720.1 (Timber structures - Design methods). Steel framing and structural steel members Steel framing: to be in accordance with Part H1D6 'Framing' of the NCC - BCA 2022 (Volume 2) and Part 6.3 'Structural steel members' of the NCC -BCA 2022 (Housing Provisions Standard) and AS 4100 (Steel structures) Cold-formed steel framing: Provide a proprietary system designed to AS 3623 (Domestic metal framing).

#### Roof and wall cladding

Roof tiling

To be in accordance with Part H1D7 and H2D6 'Roof and wall cladding' of the NCC - BCA 2022 (Volume 2), Part 7.3 'Roof tiles and shingles' of the NCC - BCA 2022 (Housing Provisions Standard) and AS 2049 (Roof tiles)

Roof tile installation: To AS 2050 (Installation of roofing tiles).

Metal roof sheeting

To be in accordance with Part H1D7 and H2D6 'Roof and wall cladding' of the NCC - BCA 2022 (Volume 2) and Part 7.2 'Sheet roofing' of the NCC - BCA 2022 (Housing Provisions Standard) Metal roofing design and installation: To AS 1562.1 (Design and installation of sheet roof and wall cladding - Metal).

Roof plumbing To be in accordance with Part H2D6 'Roof and wall cladding' of the NCC - BCA 2022 (Volume 2), Part 7.4 'Gutters and Downpipes' of the NCC - BCA 2022 (Housing Provisions Standard) and AS/NZS 3500 (Part 3 - Stormwater drainage) and AS/NZS 3500 (Part 5 - Domestic installation - section 5 stormwater drainage).

Wall cladding Timber, composite and metal wall cladding to be in accordance with Part H1D7 and H2D6 'Roof and wall cladding' and Part 7.5 'Timber and composite wall cladding' to NCC - BCA 2022 (Housing Provisions Standard).

Installation and sarking Bulk insulation: To AS/NZS 4859.1 (Materials for the thermal insulation of buildings - General criteria and technical provisions), Section 5. Reflective insulation: To AS/NZS 4859.1, Section 9. Sarking material: To AS/NZS 4200.1 (Pliable building materials and underlays -Materials). Vapour permeable membrane.

#### Windows and doors

Glazing to be in accordance with Part H1D8 and H2D7 'Glazing' of the NCC - BCA 2022 (Volume 2) and Part 8 'Glazing' of the NCC - BCA 2022 (Housing Provisions Standard). Glass Selection and installation: To AS 1288 (Glass

in buildings - Selection and installation) Timber doorsets: To AS 2688 (Timber doors) Timber frames and jamb linings: To AS 2689 (Timber doorsets)

Security screen doors and window grilles: To AS 5039 (Security screen doors and security window

Window selection and installation: To AS 2047 (Windows in buildings - Selection and installation) Doorset installation: To AS 1909 (Installation of timber doorsets).

Garage doors: To AS/NZS 4505 (Domestic garage

#### Lining

Plasterboard: To AS/NZS 2588 (Gypsum plasterboard).

Plasterboard installation: To AS/NZS 2589.1 (Gypsum linings in residential and light commercial construction - Application and finishing - Gypsum plasterboard) Level 4 finish.

Fibre cement: To AS/NZS 2908.2 (Cellulose cement products - Flat Sheets), Type B, Category 2.

Fibrous plaster products: To AS 2185 (Fibrous plaster products).

#### Fire safety

Fire Safety to be in accordance with parts: - H3 'Fire Safety' of the NCC - BCA 2022 (Volume

- Part 9 'Fire Safety' of the NCC - BCA 2022 (Housing Provisions Standard) Smoke alarms

To be in accordance with Part H3D6 'Smoke alarms and evacuation lighting' of the NCC - BCA 2022 (Volume 2), Part 9.5 'Smoke alarms and evacuation lighting' of the NCC - BCA 2022 (Housing Provisions Standard) and AS 3786 (Smoke alarms)

Smoke alarms will be hardwired and interconnected in accordance with AS3786-2014 and BCA Clause

#### Health and amenity

Wet areas

Refer to "Waterproofing".

Room heights

To be in accordance with Part H4D4 'Room Heights' of the NCC - BCA 2022 (Volume 2) and Part 10.3 'Room heights' of the NCC - BCA 2022 (Housing Provisions Standard).

Kitchen, sanitary and washing facilities To be in accordance with Part H4D5 'Facilities' of the NCC - BCA 2022 (Volume 2) and Parts 10.4.1 'Required facilities' and 10.4.2 'Construction of sanitary compartments' of the NCC - BCA 2022 (Housing Provisions Standard).

Natural and artificial light

To be in accordance with Part H4D6 'Light' of the NCC - BCA 2022 (Volume 2) and Parts 10.5.1 'Natural light' and 10.5.2 'Artificial lighting' of the NCC - BCA 2022 (Housing Provisions Standard). Ventilation

To be in accordance with Part H4D7 'Ventilation' of the NCC - BCA 2022 (Volume 2) and Part 10.6 'Ventilation' of the NCC - BCA 2022 (Housing Provisions Standard). Sound insulation

To be in accordance with Part H4D8 'Sound insulation' of the NCC - BCA 2022 (Volume 2) and

Part 10.7 'Sound insulation' of the NCC - BCA 2022 (Housing Provisions Standard).

### Safe movement and access

Stair construction

To be in accordance with Part H5D2 'Stairway and ramp construction' of the NCC - BCA 2022 (Volume 2) and Parts 11.2 'Stairway and ramp construction' of the NCC - BCA 2022 (Housing Provisions Standard) Balustrades

To be in accordance with Part H5D3 'Barriers and handrails' of the NCC - BCA 2022 (Volume 2) and Part 11.3 'Barriers and handrails' of the NCC - BCA 2022 (Housing Provisions Standard).

#### Block and tile finishes

Ceramic tiling: Follow the guidance provided by AS 3958.1 (Ceramic tiles - Guide to the installation of ceramic tiles) and AS 3958.2 (Ceramic tiles - Guide to the selection of a ceramic tiling system)

Adhesives: To AS 2358 (Adhesives - For fixing ceramic tiles).

#### Waterproofing

To be in accordance with Part H4D2 'Wet Areas' of the NCC - BCA 2022 (Volume 2) and part 10.2 'Wet area waterproofing' of the NCC - BCA 2022 (Housing Provisions Standard) Waterproofing: To AS 3740 (Waterproofing of wet areas in residential buildings).

#### Floor coatings and coverings

Carpeting: To AS/NZS 2455.1 (Textile floor coverings - Installation practice - General). Resilient finishes: To AS 1884 (Floor coverings -Resilient sheet and tiles - Laying and maintenance practices).

#### Painting

Painting generally: Follow the guidance provided by AS/NZS 2311 (Guide to the painting of buildings) and AS/NZS 2312 (Guide to the protection of structural steel against atmospheric corrosion by the use of protective coatings).

#### Plumbing installations

Where a discrepancy arises the hydraulic consultant's, local or statutory authority's requirements take precedence over the following standards to the extent of the discrepancy.

Plumbing and draining products: To SAA MP52 (Manual of authorization procedures for plumbing and drainage products) and AS/NZS 3718 (Water supply - Tap ware). Stormwater: To AS/NZS 3500.3 (Plumbing and

Drainage - Stormwater drainage) or AS/NZS 3500.5 (National Plumbing and Drainage - Domestic installations). Wastewater: To AS/NZS 3500.2 (Plumbing and Drainage - Sanitary plumbing and drainage) or

AS/NZS 3500.5. Freshwater: To AS/NZS 3500.1 (Plumbing and Drainage - Water services) and AS/NZS 3500.4 (Plumbing and Drainage - Heated water services) or AS/NZS 3500.5.

Gas: To AS 5601 (Gas installation code).

#### Electrical installations

Where a discrepancy arrises the electrical consultant's, local or statutory authority's requirements take precedence over the following standards to the extent of the discrepancy. Electrical installation: To AS/NZS 3018 (Electrical installation - Domestic installations). Smoke detectors: Refer to "Fire Safety, Smoke

Smoke detection installation and testing: To AS 1670.1 (Fire detection, warning, control and intercom systems - System design, installation, and commissioning - Fire) in accordance with the requirements of the Building Code of Australia. Connect smoke detectors to mains nowe Test electrical installations: To AS/NZS 3017 (Electrical installations - Testing guidelines). Certify compliance with AS/NZS 3018.

#### Mechanical installations

Mechanical ventilation: To AS 1668.2 (The use of ventilation and air-conditioning in buildings -Mechanical ventilation for acceptable indoor quality) - Grade 2 amenity.

#### **Condensation Management**

To be in accordance with part H4D9 'Condensation management' of the NCC - BCA 2022 and part 10.8 'Condensation management' of the NCC - BCA 2022 (Housing Provisions Standard) Pliable membrane to be installed in the external walls in accordance with AS/NZS4200.1 and AS4200.2 except for single skin masonry or single skin concrete, where a pliable building membrane is not installed in an external wall, the primary water control layer must be separated from water sensitive materials by a drained cavity.

Alterations & Additions

At: 107 Crinan Street. Hurlstone Park

For: Donna & George Georgiou

Development Application & Construction Certificate



#### True North Design & Drafting Pty Ltd design@truenorthdd.com.au www.truenorthdd.com.au

Issue:	Description:	By:	Date:
Α	Design Review	D.K.	20/04/2024
В	Variations	D.K.	29/05/2024
С	Variations	D.K.	08/06/2024
D	Variations	D.K.	19/06/2024
E	Variations	D.K.	04/09/2024
F	Variations	D.K.	22/10/2024
1	Issued for DA Submission	D.K.	19/11/2024

LEVELS SHOWN ARE APPROX.ONLY AND SHOULD BE VERIFIED ON SITE - DO NOT SCALE USE DIMENSIONS WHERE AVAILABLE.
WINDOW SIZES ARE INDICATIVE ONLY FINAL SIZES PROVIDED BY BUILDER AND CONFIRMED ON SITE.
THE DESIGNER MUST BE NOTIFED OF ANY DISCREPANCIES ON THE DRAMBURG PRIOR TO ANY CONFETURE OF THE NOTIFIED OF SITE OF THE NOTIFIED OF THE NOT

DRAWINGS PRIOR TO ANY CONSTRUCTION WORKS.
COPYRIGHT OF THIS DRAWING AND/OR DESIGN IS THE PROPERTY OF
TRUE NORTH DESIGN & DRAFTING PTY LTD AND SHOULD NOT BE REPRODUCED IN PART OR WHOLE WITHOUT THE WRITTEN PERMISSION

DIAL 1100 BEFORE YOU DIG PRIOR TO ANY EARTH EXCAVATION.

COPYRIGHT ©2023 BY TRUE NORTH DESIGN & DRAFTING PTY LTD. ALL RIGHTS RESERVED.

Scale: 1:1 Page: 18 of 18 Date: 19/11/2024 Drawing No: 2409

Issue: